


**1** MECHANICAL DUCTWORK DEMOLITION FIRST FLOOR PLAN AREA  
SCALE: 1/8"=1'0"

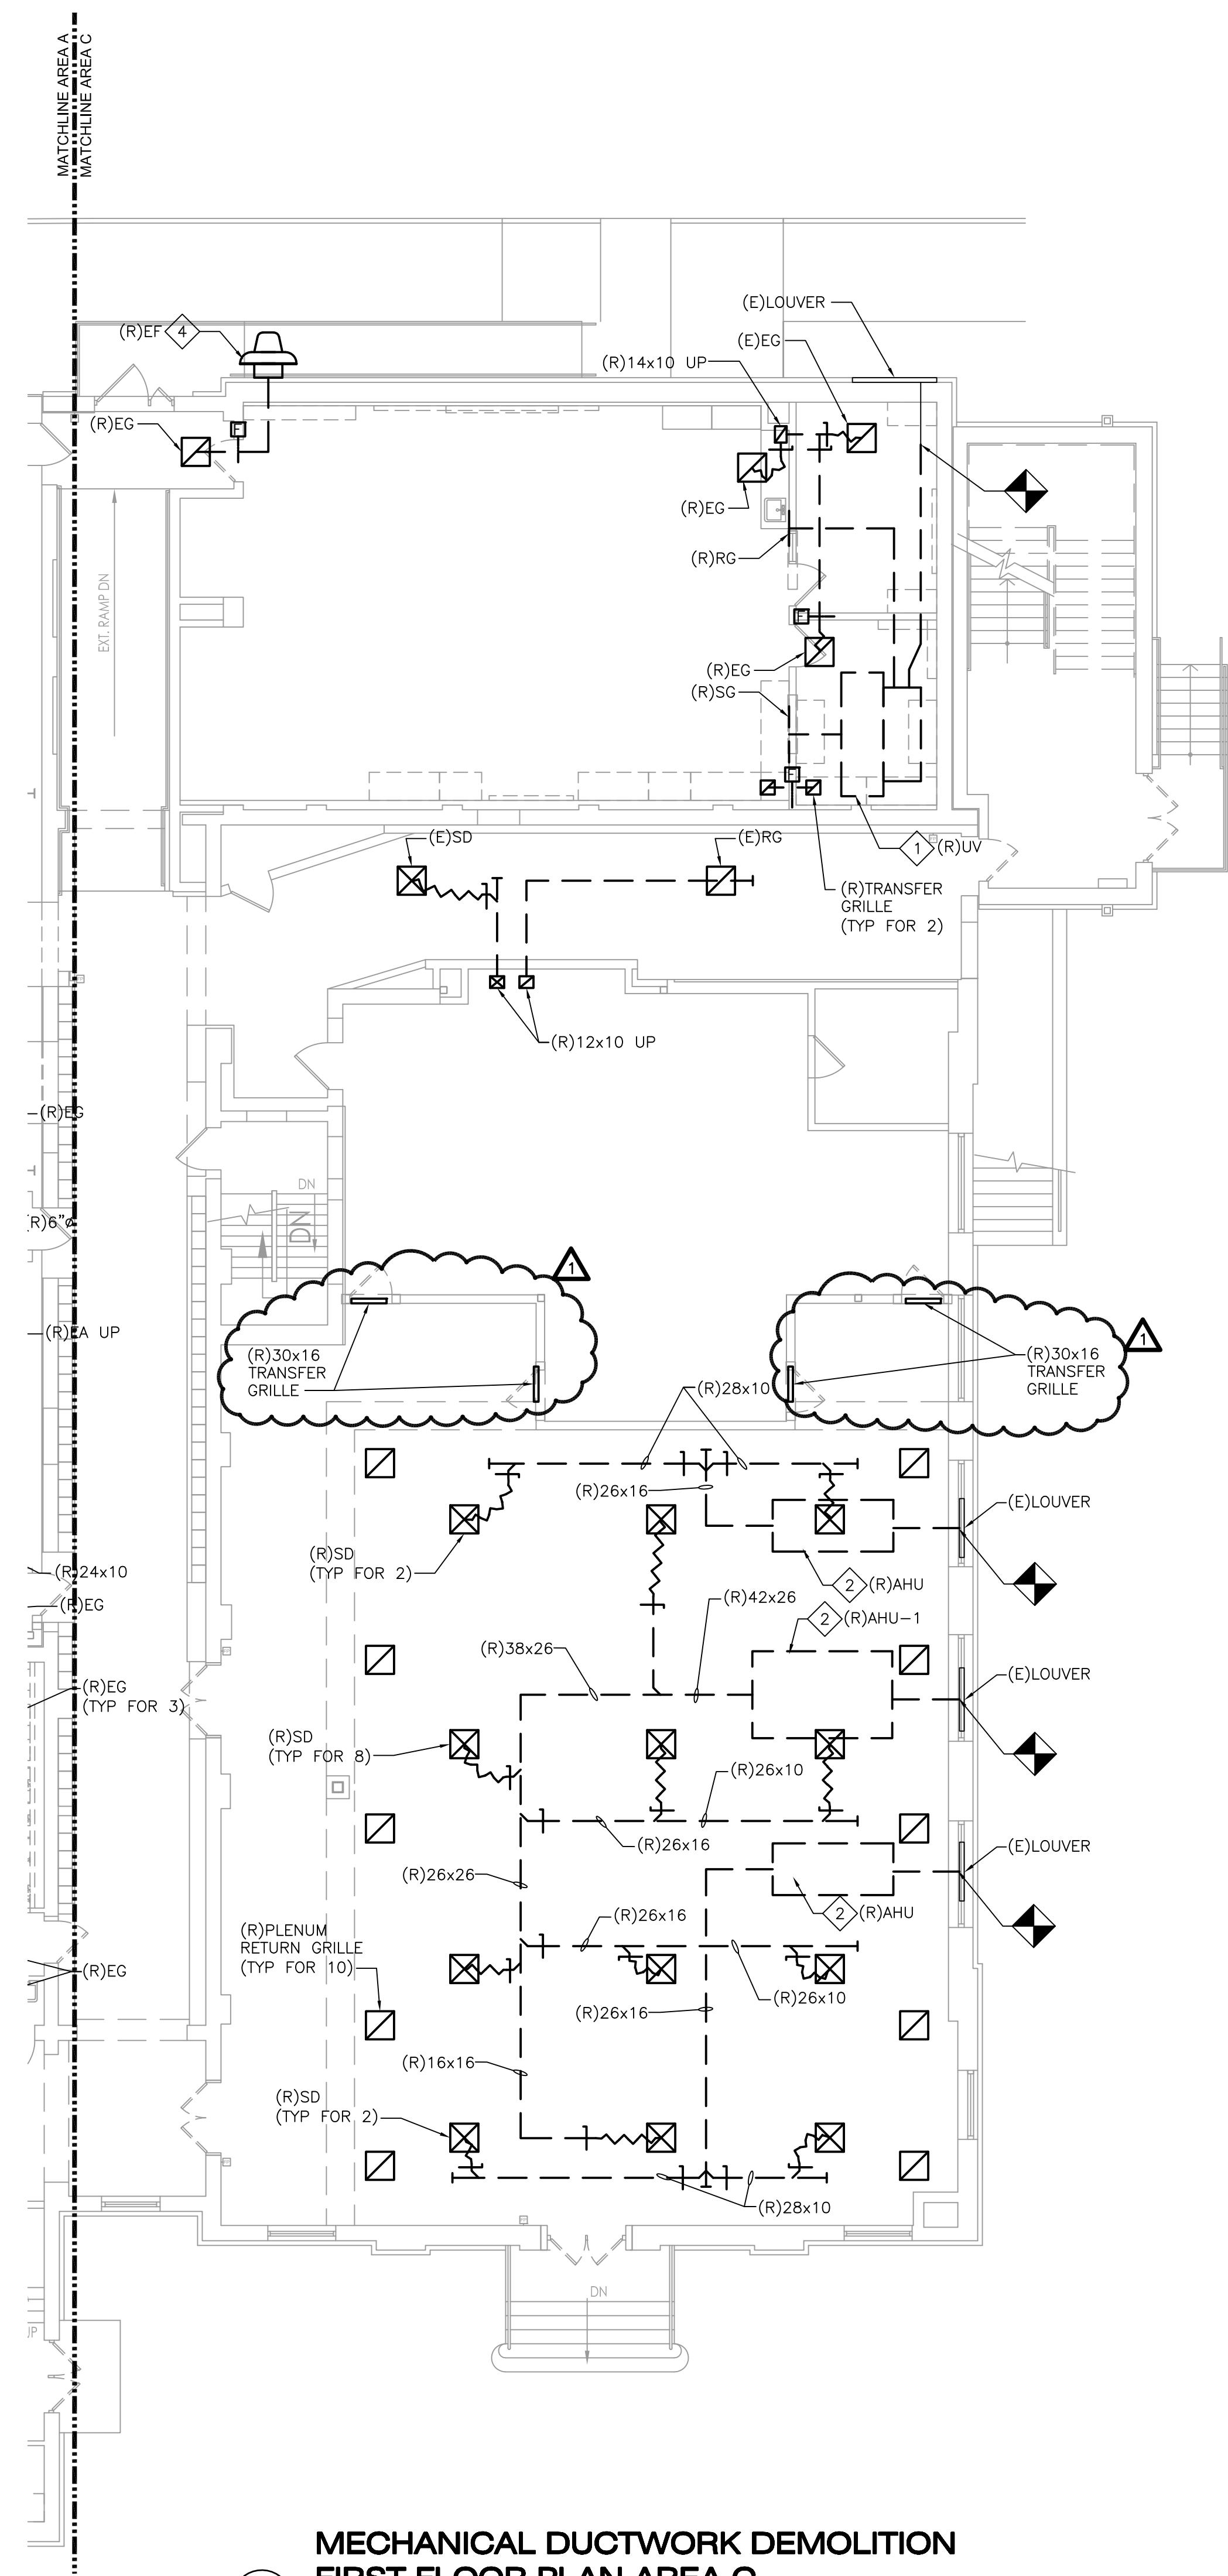

# MECHANICAL DUCTWORK DEMOLITION FIRST FLOOR PLAN AREA C

#### DEMOLITION KEY NOTES:

DEMOLITION KEY NOTES:

- 1 REMOVE UNIT VENTILATOR IN ITS ENTIRETY, INCLUDING BUT NOT LIMITED TO, ASSOCIATED HOT WATER SUPPLY AND RETURN PIPING, CHILLED WATER SUPPLY AND RETURN PIPING, WALL BOX, WIRING AND CONTROLS. BLANK OFF EXISTING LOUVER WITH DOUBLE SIDED 1" INSULATED SHEET METAL PANEL AND ABANDON.
- 2 REMOVE AIR HANDLING UNIT IN ITS ENTIRETY, INCLUDING BUT NOT LIMITED TO, ASSOCIATED HOT WATER SUPPLY AND RETURN PIPING, CHILLED WATER SUPPLY AND RETURN PIPING, SUPPLY AND RETURN DUCTWORK, GRILLES, DIFFUSERS, AIR DUCT ACCESSORIES, INSULATION, HANGERS, SUPPORTS, CONTROLS AND WIRING. BLANK OFF EXISTING LOUVER WITH DOUBLE SIDED 1" INSULATED SHEET METAL PANEL AND ABANDON.
- 3 REMOVE AND SALVAGE EXISTING 40x8 SUPPLY GRILLE. GRILLE NECK TO BE EXTENDED AND GRILLE RELOCATED ON NEW WALL.
- 4 REMOVE EXHAUST FAN IN ITS ENTIRETY, INCLUDING BUT NOT LIMITED TO, DUCTWORK, GRILLES HANGERS, SUPPORTS, CONTROLS AND WIRING. CAP OPENING WITH INSULATED METAL PLATE WEATHERTIGHT AND PAINT IN COLOR AS SELECTED BY ARCHITECT.
- 5 REMOVE FAN COIL UNIT IN ITS ENTIRETY, INCLUDING BUT NOT LIMITED TO, ASSOCIATED HOT WATER SUPPLY AND RETURN PIPING, CHILLED WATER SUPPLY AND RETURN PIPING, OUTSIDE AIR DUCTWORK, INSULATION, HANGERS, SUPPORTS, CONTROLS AND WIRING.
- 6 REMOVE FAN COIL UNIT IN ITS ENTIRETY, INCLUDING BUT NOT LIMITED TO, ASSOCIATED HOT WATER SUPPLY AND RETURN PIPING, CHILLED WATER SUPPLY AND RETURN PIPING, INSULATION, HANGERS, SUPPORTS, CONTROLS AND WIRING. BLANK OFF EXISTING LOUVER WITH DOUBLE SIDED 1" INSULATED SHEET METAL PANEL AND ABANDON.
- 7 REMOVE HOT WATER DUCT HEATING COIL INCLUDING ALL ASSOCIATED HOT WATER SUPPLY & RETURN PIPING, INSULATION, HANGERS, VALVES, SPECIALTIES, CONTROLS AND WIRING. AFTER REMOVAL OF COIL, CONNECT/PATCH EXISTING DUCTWORK SO THAT THE DUCT IS CONTINUOUS & AIRTIGHT. PROVIDE NEW INSULATION AS NEEDED TO ENSURE EXISTING DUCT IS FULLY INSULATED. FIELD VERIFY EXISTING DUCT SIZE.

## NOTES


1. REFER TO DRAWING M-001 FOR LEGEND, ABBREVIATIONS, AND GENERAL NOTES.

The logo is a diamond shape with a thick black border. Inside the diamond, there is a stylized monogram of the letters 'S' and 'H' in a blocky, geometric font. The 'S' is on the left and the 'H' is on the right, with a small ampersand symbol between them. The monogram is rendered in a light gray or silver color, creating a sense of depth within the diamond frame.

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**RICHARD L. DELP, PE  
NEW JERSEY PROFESSIONAL  
ENGINEER  
LICENSE NO.: GE45368**

## KEY PLAN:

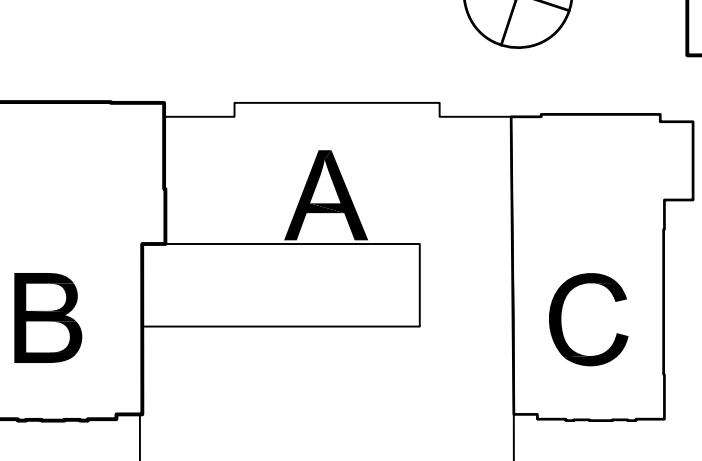

1	12/23/25	ADDENDUM 1
	12/08/25	OUT TO BID
	12/03/25	DCA Submission
No.	Date	Description
Revisions / Issues		

# DIGroupArchitecture

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DO NOT SCALE. DRAWING MAY BE PRINTED AT REDUCED  
SCALE. CONSULT WITH ARCHITECT FOR DIMENSIONS.

Client:  
Rowan University  
201 Mullica Hill Rd.  
Glassboro, NJ 08028

Project: Alterations to Facility Located at 202 Delsea Drive  
BLOCK 26 / LOT 412  
202 Delsea Dr.  
Glassboro, NJ 08028

Drawing Information:  
Project No: 25.024  
Date:  
Drawn By: TMW  
Checked By: RLD

Sheet Name: DUCTWORK DEMO 1ST FLR

Sheet No:

# MD-101B